ABBREVIATIONS

ABBREVIATION DESCRIPTION AGGREGATE BASE ASPHALT CONCRETE AMERICANS WITH DISABILITIES ACT BUILDING BLDG. BACK OF CURB BACK OF WALK COL COLUMN CONCRETE C,G, & SW CURB, GUTTER, AND SIDEWALK CATCH BASIN CITY OF STOCKTON DIAMETER **DRAWING ELEVATION EXISTING PAVEMENT EXISTING** FACE OF CURB FIRE HYDRANT GROUND **GRADE BREAK** HORIZONTAL HORIZ HIGH PRESSURE GAS LINE LINEAL FEET MAXIMUM MAINTENANCE HOLE MINIMUM MANUAL ON UNIFORM TRAFFIC CONTROL DEVICES NOT TO SCALE **PAVEMENT POWER POLE** POINT RADIAL OR RADIUS SOUTHBOUND STORM DRAIN SANITARY SEWER STREET LIGHT SIDEWALK STORM DRAIN MAINTENANCE HOLE SDMH SANITARY SEWER MAINTENANCE HOLE STD STANDARD STREET TYPICAL UNLESS OTHERWISE NOTED UNDERGROUND VAULT VERTICAL

LEGEND

PLUS OR MINUS LEFT SIDE OF ROAD RIGHT SIDE OF ROAD

WATER

EAST SOUTH NORTH

WATER SERVICE

EXISTING		PROPOSED
	PROPERTY & R/W LINE	
	EASEMENT	
	EDGE OF PAVEMENT	
\sim	STREET LIGHT	
0	SIGN	۰
6"SS	SANITARY SEWER LINE	
12"SD	STORM DRAIN LINE	
4"W	WATER LINE	
— E —— E —— E —	ELECTRICAL LINE	
— G —— G —	GAS LINE	
— TEL —— TEL —	TELECOMMUNICATION CONDUIT LINE	
— F0 —— F0 —— F0 —	FIBER OPTIC LINE	
— ЈТ — ЈТ —	JOINT TRENCH	
Processing Control of	STORM DRAIN INLET	
0	MAINTENANCE HOLE	
TSB	TRAFFIC SIGNAL PULL BOX	
EL	ELECTRICAL PULL BOX	
SL	STREET LIGHT PULL BOX	
V	ELECTRICAL VAULT	
	RECTANGULAR RAPID FLASHING BEACON SYSTEM	XI B CE
	FIRE HYDRANT	
×	GATE VALVE	
8	WATER VALVE	

E helow

BENCH MARK:

CITY OF STOCKTON BENCHMARK NO. 14

BRASS DISK MARKING COS MONUMENT STAMPED 1N-2 IN MONUMENT WELL ON THE EAST SIDE OF PACIFIC AVE AT THE APPROXIMATE CENTERLINE OF YOKUTS ROAD ELEVATION = 12.73


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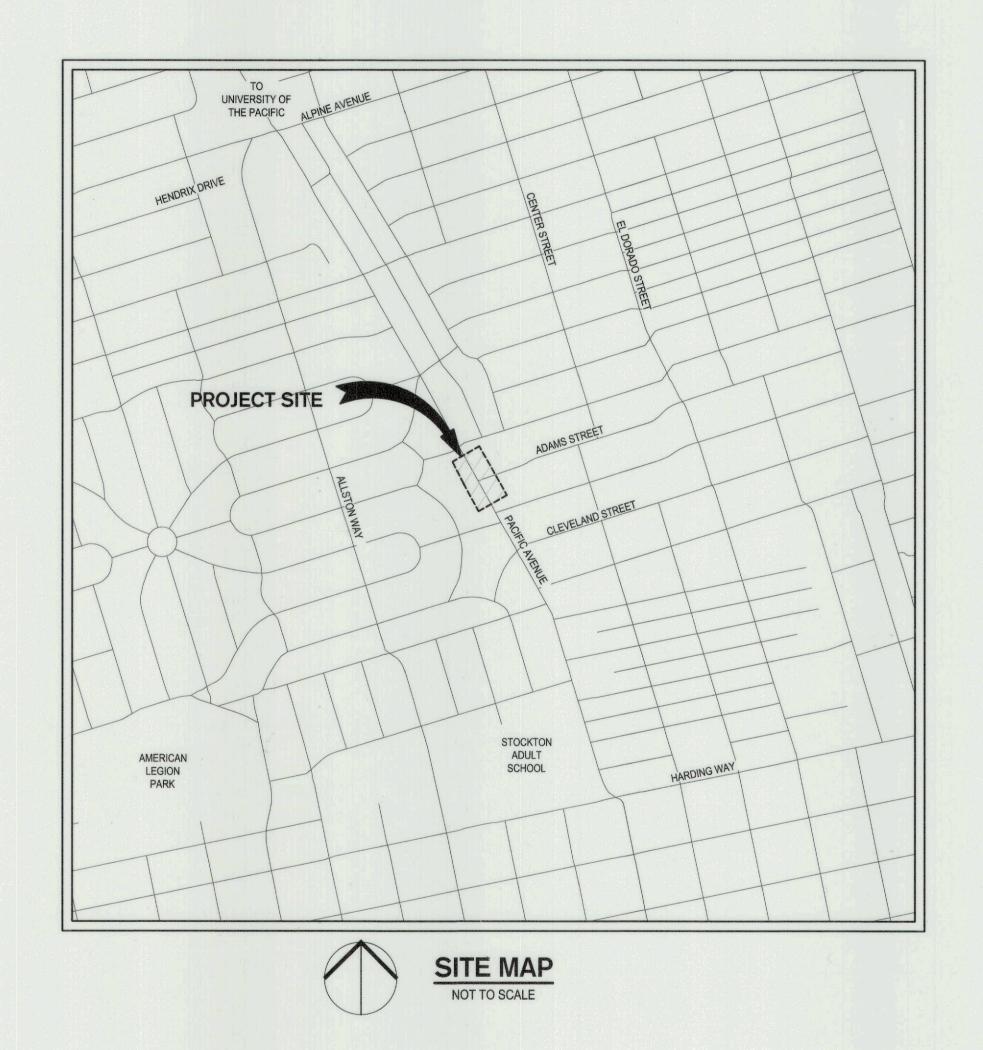
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MIRACLE MILE RECTANGULAR RAPID FLASHING BEACON IMPROVEMENTS

PROJECT NO. WT22052

CITY OF STOCKTON, CALIFORNIA



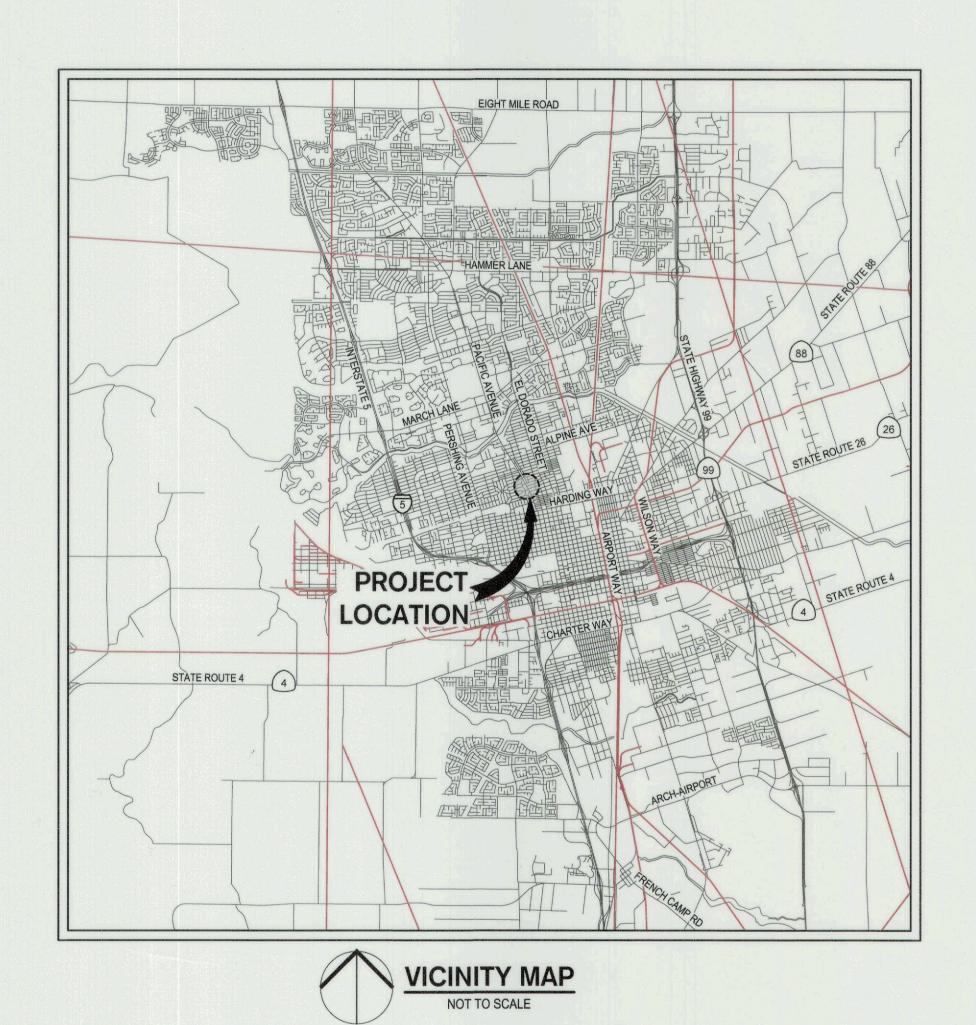

INDEX OF SHEETS

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C1.0	TITLE SHEET
C2.0	GENERAL NOTES, ABBREVIATION, AND LEGEND
C3.0	TOPOGRAPHIC AND DEMOLITION PLAN
C4.0	PAVING AND DIMENSIONING PLAN
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C6.0	EROSION CONTROL GUIDELINES
SL1.0	STREET LIGHTING PLAN
SS1.0	SIGNAGE AND STRIPING PLAN



			STRUC ENGINE	EERING	MIRACLE MILE RECTANGULAR RAPID FLASHING BEACON
SIEGFRIED **LANDSCAPE ARCHITECTURE **LAND SURVEYING* 3244 Brookside Road, Suite 100 Stockton, California 95219 209-943-2021 www.siegfriedeng.com Fx: 209-942-0214					TITLE SHEET
Revision No.	Description	Date	Ву	Apprvd. By	DEPARTMENT OF PUBLIC WORKS CITY OF STOCKTON, CALIFORNIA
					SCALE AS SHOWN APPROVED BY: 5/3/23 SHEET NO.
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					DRAWN BY MJK OF 8 SHEETS
				TRAFFIL	CHECKED BY PJS CITY ENGINEER WT22052
					RECORD DWGS. STOCKTON, CALIFORNIA PROJECT NO.

GENERAL NOTES

- 1. ALL IMPROVEMENTS SHALL BE CONSTRUCTED IN STRICT ACCORDANCE WITH THE FOLLOWING: THE CURRENT CITY OF STOCKTON STANDARD SPECIFICATIONS AND PLANS, AND ALL AMENDMENTS THERETO TO DATE, CALIFORNIA DEPARTMENT OF TRANSPORTATION STANDARD SPECIFICATIONS (CALTRANS) LATEST EDITION, WHERE APPLICABLE, AND CALIFORNIA MANUAL ON UNIFORM TRAFFIC CONTROL DEVICES (CA MUTCD) LATEST EDITION, WHERE APPLICABLE. WHERE THERE IS A CONFLICT BETWEEN THE PLANS AND THE CITY'S STANDARD SPECIFICATIONS AND PLANS, THE CITY OF STOCKTON STANDARD SPECIFICATION AND PLANS SHALL PREVAIL. ALL WORK SHALL BE SUBJECT TO INSPECTION BY THE CITY OF STOCKTON.
- 2. THE CITY OF STOCKTON STANDARD PLANS AND DETAILS AS SHOWN HEREON ARE FOR THE CONVENIENCE OF THE CONTRACTOR. PRIOR TO AND DURING CONSTRUCTION, THE CONTRACTOR SHALL BE RESPONSIBLE FOR BEING FAMILIAR WITH THE CURRENT CITY OF STOCKTON STANDARDS AND ALL UPDATES AND REVISIONS MADE TO ANY OF THE CITY OF STOCKTON STANDARD DETAILS SHOWN ON THESE PLANS. THE CONTRACTOR IS ALSO RESPONSIBLE FOR BEING FAMILIAR WITH THE WRITTEN SPECIFICATIONS AND/OR OTHER STANDARD DETAILS NOT SHOWN BUT WHICH ARE INCLUDED IN THE CITY OF STOCKTON STANDARD SPECIFICATIONS AND PLANS.
- 3. EXISTING UTILITIES ARE SHOWN AS THEY ARE BELIEVED TO EXIST. THE OWNER AND THE ENGINEER DO NOT ACCEPT RESPONSIBILITY FOR THEIR ACCURACY. IT SHALL BE THE CONTRACTOR'S RESPONSIBILITY TO PROTECT ALL EXISTING UTILITIES.
- 4. ATTENTION IS CALLED TO: SECTION 1540 (A) (1) OF THE CONSTRUCTION SAFETY ORDERS (TITLE 8 CALIFORNIA ADMINISTRATION CODE SECTION 1540), ISSUED BY THE OCCUPATIONAL SAFETY AND HEALTH STANDARDS BOARD PURSUANT TO THE CALIFORNIA OCCUPATIONAL SAFETY AND HEALTH ACT OF 1973, AS AMENDED, WHICH STATES:

 "PRIOR TO OPENING AN EXCAVATION, EFFORT SHALL BE MADE TO DETERMINE WHETHER UNDERGROUND INSTALLATION I.E., SEWER, WATER, FUEL, ELECTRIC LINES, ETC., WILL BE ENCOUNTERED AND, IF SO, WHERE SUCH UNDERGROUND INSTALLATIONS ARE LOCATED. WHEN THE EXCAVATION APPROACHES THE APPROXIMATE LOCATION OF SUCH AN INSTALLATION, THE EXACT LOCATION SHALL BE DETERMINED BY CAREFUL PROBING OR HAND DIGGING AND WHEN IT IS UNCOVERED, ADEQUATE PROTECTION SHALL BE PROVIDED FOR THE EXISTING INSTALLATION. ALL KNOWN OWNERS OF UNDERGROUND FACILITIES IN THE AREA CONCERNED SHALL BE ADVISED OF PROPOSED WORK AT
- THE CONTRACTOR SHALL NOTIFY MEMBERS OF THE UNDERGROUND SERVICE ALERT (U.S.A.) 48 HOURS IN ADVANCE OF PERFORMING EXCAVATION WORK BY CALLING THE TOLL-FREE NUMBER (800-227-2600).

LEAST 48 HOURS PRIOR TO THE START OF ACTUAL EXCAVATION."

- 6. IT SHALL BE CONTRACTOR'S SOLE RESPONSIBILITY TO PROTECT ALL EXISTING UTILITIES SO THAT NO DAMAGE RESULTS TO THEM DURING THE PERFORMANCE OF HIS CONTRACT. THE CONTRACTOR SHALL BE REQUIRED TO COOPERATE WITH OTHER CONTRACTORS AND UTILITY COMPANIES INSTALLING NEW STRUCTURES, UTILITIES AND SERVICES TO THE DEVELOPMENT.
- 7. SURVEY MONUMENT PRESERVATION:
 PRIOR TO CONSTRUCTION, CONTRACTOR SHALL ENGAGE A LICENSED SURVEYOR TO PERFORM A PRE-CONSTRUCTION
 MONUMENT PRESERVATION SURVEY IN ACCORDANCE WITH SECTIONS 8771(b) OF THE BUSINESS AND PROFESSIONS CODE
 OF THE STATE OF CALIFORNIA. LOCATIONS OF EXISTING MONUMENTATION KNOWN TO THE ENGINEER THAT ARE WITHIN THE
 AREA OF PROJECT HAVE BEEN INDICATED ON THE PLANS FOR REFERENCE. AT THE COMPLETION OF CONSTRUCTION, BUT
 PRIOR TO FINAL APPROVAL OF THE IMPROVEMENTS, CONTRACTOR'S LICENSED SURVEYOR SHALL PERFORM A
 POST-CONSTRUCTION MONUMENT PRESERVATION SURVEY IN ACCORDANCE WITH SECTIONS 8771(c) AND 8771(d), AND, IF
 NECESSARY, FILE A RECORD OF SURVEY OR CORNER RECORD(S) IN ACCORDANCE WITH SECTION 8771(f).
- 8. THE CONTRACTOR SHALL BE RESPONSIBLE FOR ALL PERMITS AND LICENSES REQUIRED FOR THE CONSTRUCTION AND COMPLETION OF THE PROJECT AND SHALL PERFORM ALL WORK IN ACCORDANCE WITH THE REQUIREMENTS AND CONDITIONS OF ALL PERMITS AND APPROVALS APPLICABLE TO THIS PROJECT. THE CONTRACTOR SHALL ENSURE THAT THE NECESSARY PERMITS AND/OR LICENSES ARE SECURED PRIOR TO CONSTRUCTION.
- 9. CONTRACTOR SHALL OBTAIN AN ENCROACHMENT PERMIT FROM THE CITY OF STOCKTON FOR ANY WORK DONE WITHIN CITY RIGHTS-OF-WAY OR ON CITY-OWNED FACILITIES WITHIN AN EASEMENT. CONTRACTOR SHALL CALL THE PERMIT CENTER AT (209) 937-8366 TO REQUEST A CONTROL NUMBER AND ACTIVATE THE PERMIT NO LESS THAN 24 HOURS, BUT NOT IN EXCESS OF 72 HOURS PRIOR TO START OF WORK.
- 10. ALL STATIONS REFER TO DISTANCES ALONG STREET CENTERLINE, UNLESS OTHERWISE NOTED. ALL STATIONS OFF CENTERLINE ARE PERPENDICULAR TO OR RADIALLY OPPOSITE CENTERLINE STATIONS.
- 11. THE CONTRACTOR SHALL RECEIVE PRIOR APPROVAL FROM THE ENGINEER FOR ANY EXTRA WORK. THE CONTRACTOR SHALL BE HELD RESPONSIBLE FOR ANY FIELD CHANGES MADE WITHOUT PRIOR WRITTEN AUTHORIZATION FROM THE ENGINEER AT NO ADDITIONAL COST TO THE CITY.
- 12. THE CONTRACTOR SHALL BE RESPONSIBLE FOR FOR PROTECTING FROM DAMAGE ALL EXISTING AND NEWLY PLACED IMPROVEMENTS THAT ARE TO REMAIN. SUCH CITY IMPROVEMENTS THAT ARE DAMAGED BY THE CONTRACTOR SHALL BE REPLACED AT NO ADDITIONAL COST TO THE CITY.
- 13. THE CONTRACTOR AGREES THAT HE SHALL ASSUME SOLE AND COMPLETE RESPONSIBILITY FOR JOB SITE CONDITIONS DURING THE COURSE OF CONSTRUCTION OF THIS PROJECT INCLUDING SAFETY AND SECURITY OF JOB SITE, THAT THIS REQUIREMENT SHALL APPLY CONTINUOUSLY AND NOT BE LIMITED TO NORMAL WORKING CONDITIONS.
- 14. THE CONTRACTOR SHALL MAINTAIN A NEATLY MARKED SET OF FULL-SIZE AS-BUILT DRAWINGS SHOWING THE FINAL LOCATION OF FINAL IMPROVEMENTS. AS-BUILT DRAWINGS SHALL REFLECT CHANGE ORDERS, ACCOMMODATIONS, AND ADJUSTMENTS TO ALL IMPROVEMENTS CONSTRUCTED. WHERE NECESSARY, SUPPLEMENTAL DRAWINGS SHALL BE PREPARED AND SUBMITTED BY THE CONTRACTOR.
- 15. IT SHALL BE CONTRACTOR'S SOLE RESPONSIBILITY TO PROTECT ALL EXISTING UTILITIES SO THAT NO DAMAGE RESULTS TO THEM DURING THE PERFORMANCE OF HIS CONTRACT. THE CONTRACTOR SHALL BE REQUIRED TO COOPERATE WITH OTHER CONTRACTORS AND UTILITY COMPANIES INSTALLING NEW OR MODIFIED STRUCTURES, UTILITIES AND SERVICES WITHIN THE PROJECT LIMITS.
- 16. THE CONTRACTOR SHALL EXERCISE DUE CAUTION AND SHALL CAREFULLY PRESERVE BENCHMARKS, CONTROL POINTS, REFERENCE POINTS AND ALL SURVEY MONUMENTS, AND SHALL BEAR ALL EXPENSES FOR REPLACEMENT AND/OR ERROR CAUSED BY HIS UNNECESSARY LOSS OR DISTURBANCE. THE CONTRACTOR SHALL CONSULT WITH A LICENSED LAND SURVEYOR OR CIVIL ENGINEER LICENSED TO PRACTICE LAND SURVEYING IN CALIFORNIA PRIOR TO BEGINNING CONSTRUCTION TO ENSURE THAT ANY PRECONSTRUCTION CORNER RECORDS, AS REQUIRED BY THE STATE OF CALIFORNIA PROFESSIONAL LAND SURVEYOR ACT HAVE BEEN FILED WITH THE COUNTY SURVEYOR, PURSUANT TO SECTION 877(A-F) OF THE CALIFORNIA BUSINESS AND PROFESSION CODE.
- 17. ALL WORK IN THE PUBLIC RIGHT-OF-WAY IS SUBJECT TO THE APPROVAL AND ACCEPTANCE OF THE ENGINEER.
- 18. PRIOR TO PLACEMENT OF ANY FINISH ASPHALT CONCRETE OR CONCRETE, THE CONTRACTOR SHALL VERIFY ALL FINISH GRADES AND SLOPES FOR COMPLIANCE WITH THE AMERICANS WITH DISABLITIES ACT (ADA) AND OBTAIN APPROVAL AND ACCEPTANCE BY THE ENGINEER.

SIGNING AND STRIPING GENERAL NOTES:

- THE CONTRACTOR SHALL PROVIDE ALL LIGHTS, BARRICADES, SIGNS, FLAGMEN OR
 OTHER DEVICES NECESSARY FOR PUBLIC SAFETY.
- THE CONTRACTOR SHALL SUBMIT A TRAFFIC CONTROL AND/OR DETOUR PLAN FOR APPROVAL BY THE CITY OF STOCKTON TRAFFIC ENGINEER PRIOR TO THE START OF CONSTRUCTION.
- ALL PAVEMENT MARKINGS, STRIPING AND CROSSWALKS SHALL BE THERMOPLASTIC.
- 4. STRIPING AND PAVEMENT MARKINGS SHALL BE IN STRICT CONFORMANCE WITH THE CA-MUTCD (LATEST EDITION) AND THE SPECIAL PROVISIONS SECTION 84. PAVEMENT MARKINGS SHALL ALSO CONFORM TO THE CAL TRANS SPECIFICATIONS (LATEST EDITION) SECTION 84.
- SIGNING SHALL CONFORM TO THE CA-MUTCD (LATEST EDITION) AND CALTRANS SPECIFICATIONS (LATEST EDITION) SECTION 82.
- REMOVAL OF EXISTING PAVEMENT MARKINGS SHALL BE REMOVED BY GRINDING PER CAL TRANS STANDARDS SPECIFICATIONS SECTION 84-9.
- CONTRACTOR SHALL INSTALL A BLUE REFLECTOR ON FIRE HYDRANT SIDE AT ALL FIRE HYDRANT LOCATIONS PER CA-MUTCD, SECTION 3B.11 AND FIGURE 3B-102.
- 8. THE CONTRACTOR SHALL NOTIFY THE ENGINEER A MINIMUM OF THREE (3) WORKING DAYS IN ADVANCE OF THE LAYOUT AND CAT-TRACKING OF THE PROPOSED IMPROVEMENTS. CAT-TRACKING TO BE APPROVED BY TRAFFIC ENGINEERING PRIOR TO FINAL ACCEPTANCE OF STRIPING AND PAVEMENT MARKINGS.
- 9. THE CONTRACTOR SHALL ENSURE THAT THE APPROPRIATE STRIPING AND PAVEMENT MARKINGS ARE IN PLACE AT ALL TIMES. TEMPORARY STRIPING AND/OR PAVEMENT MARKINGS SHALL BE INSTALLED TO REPLACE ANY EXISTING STRIPING OR MARKINGS WHICH HAVE BEEN REMOVED. ANY CONFLICTING STRIPING SHALL BE REMOVED IMMEDIATELY BY THE CONTRACTOR PRIOR TO REOPENING THE STREET TO TRAFFIC.
- 10. THE CONTRACTOR SHALL REMOVE ANY EXISTING SIGNS IN CONFLICT WITH THESE PLANS AS DIRECTED BY THE CITY TRAFFIC ENGINEER. EXISTING STRIPING AND MARKINGS IN CONFLICT WITH THESE PLANS SHALL BE REMOVED BY THE CONTRACTOR. PAVEMENT SHALL BE REPAIRED IF DAMAGED IN CONJUNCTION WITH REMOVAL OF MARKERS.
- R30E (CA) "NO PARKING" SIGNS ARE TO BE INSTALLED AT A 45° ANGLE FACING DIRECTION OF TRAFFIC FLOW. SIGN SIZE SHALL BE 12" X 18".
- 12. ALL DIMENSIONS SHOWN ARE FROM FACE OF CURB, UNLESS OTHERWISE NOTED.
- THE CONTRACTORS SHALL REPLACE ANY PAVEMENT DELINEATION AND TRAFFIC MARKINGS THAT ARE DAMAGED DURING THE COURSE OF WORK AT NO ADDITIONAL COST TO THE CITY.


BENCH MARK:
CITY OF STOCKTON BENCHMARK NO. 14

BRASS DISK MARKING COS MONUMENT STAMPED 1N-2
IN MONUMENT WELL ON THE EAST SIDE OF PACIFIC AVE
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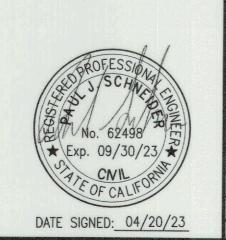


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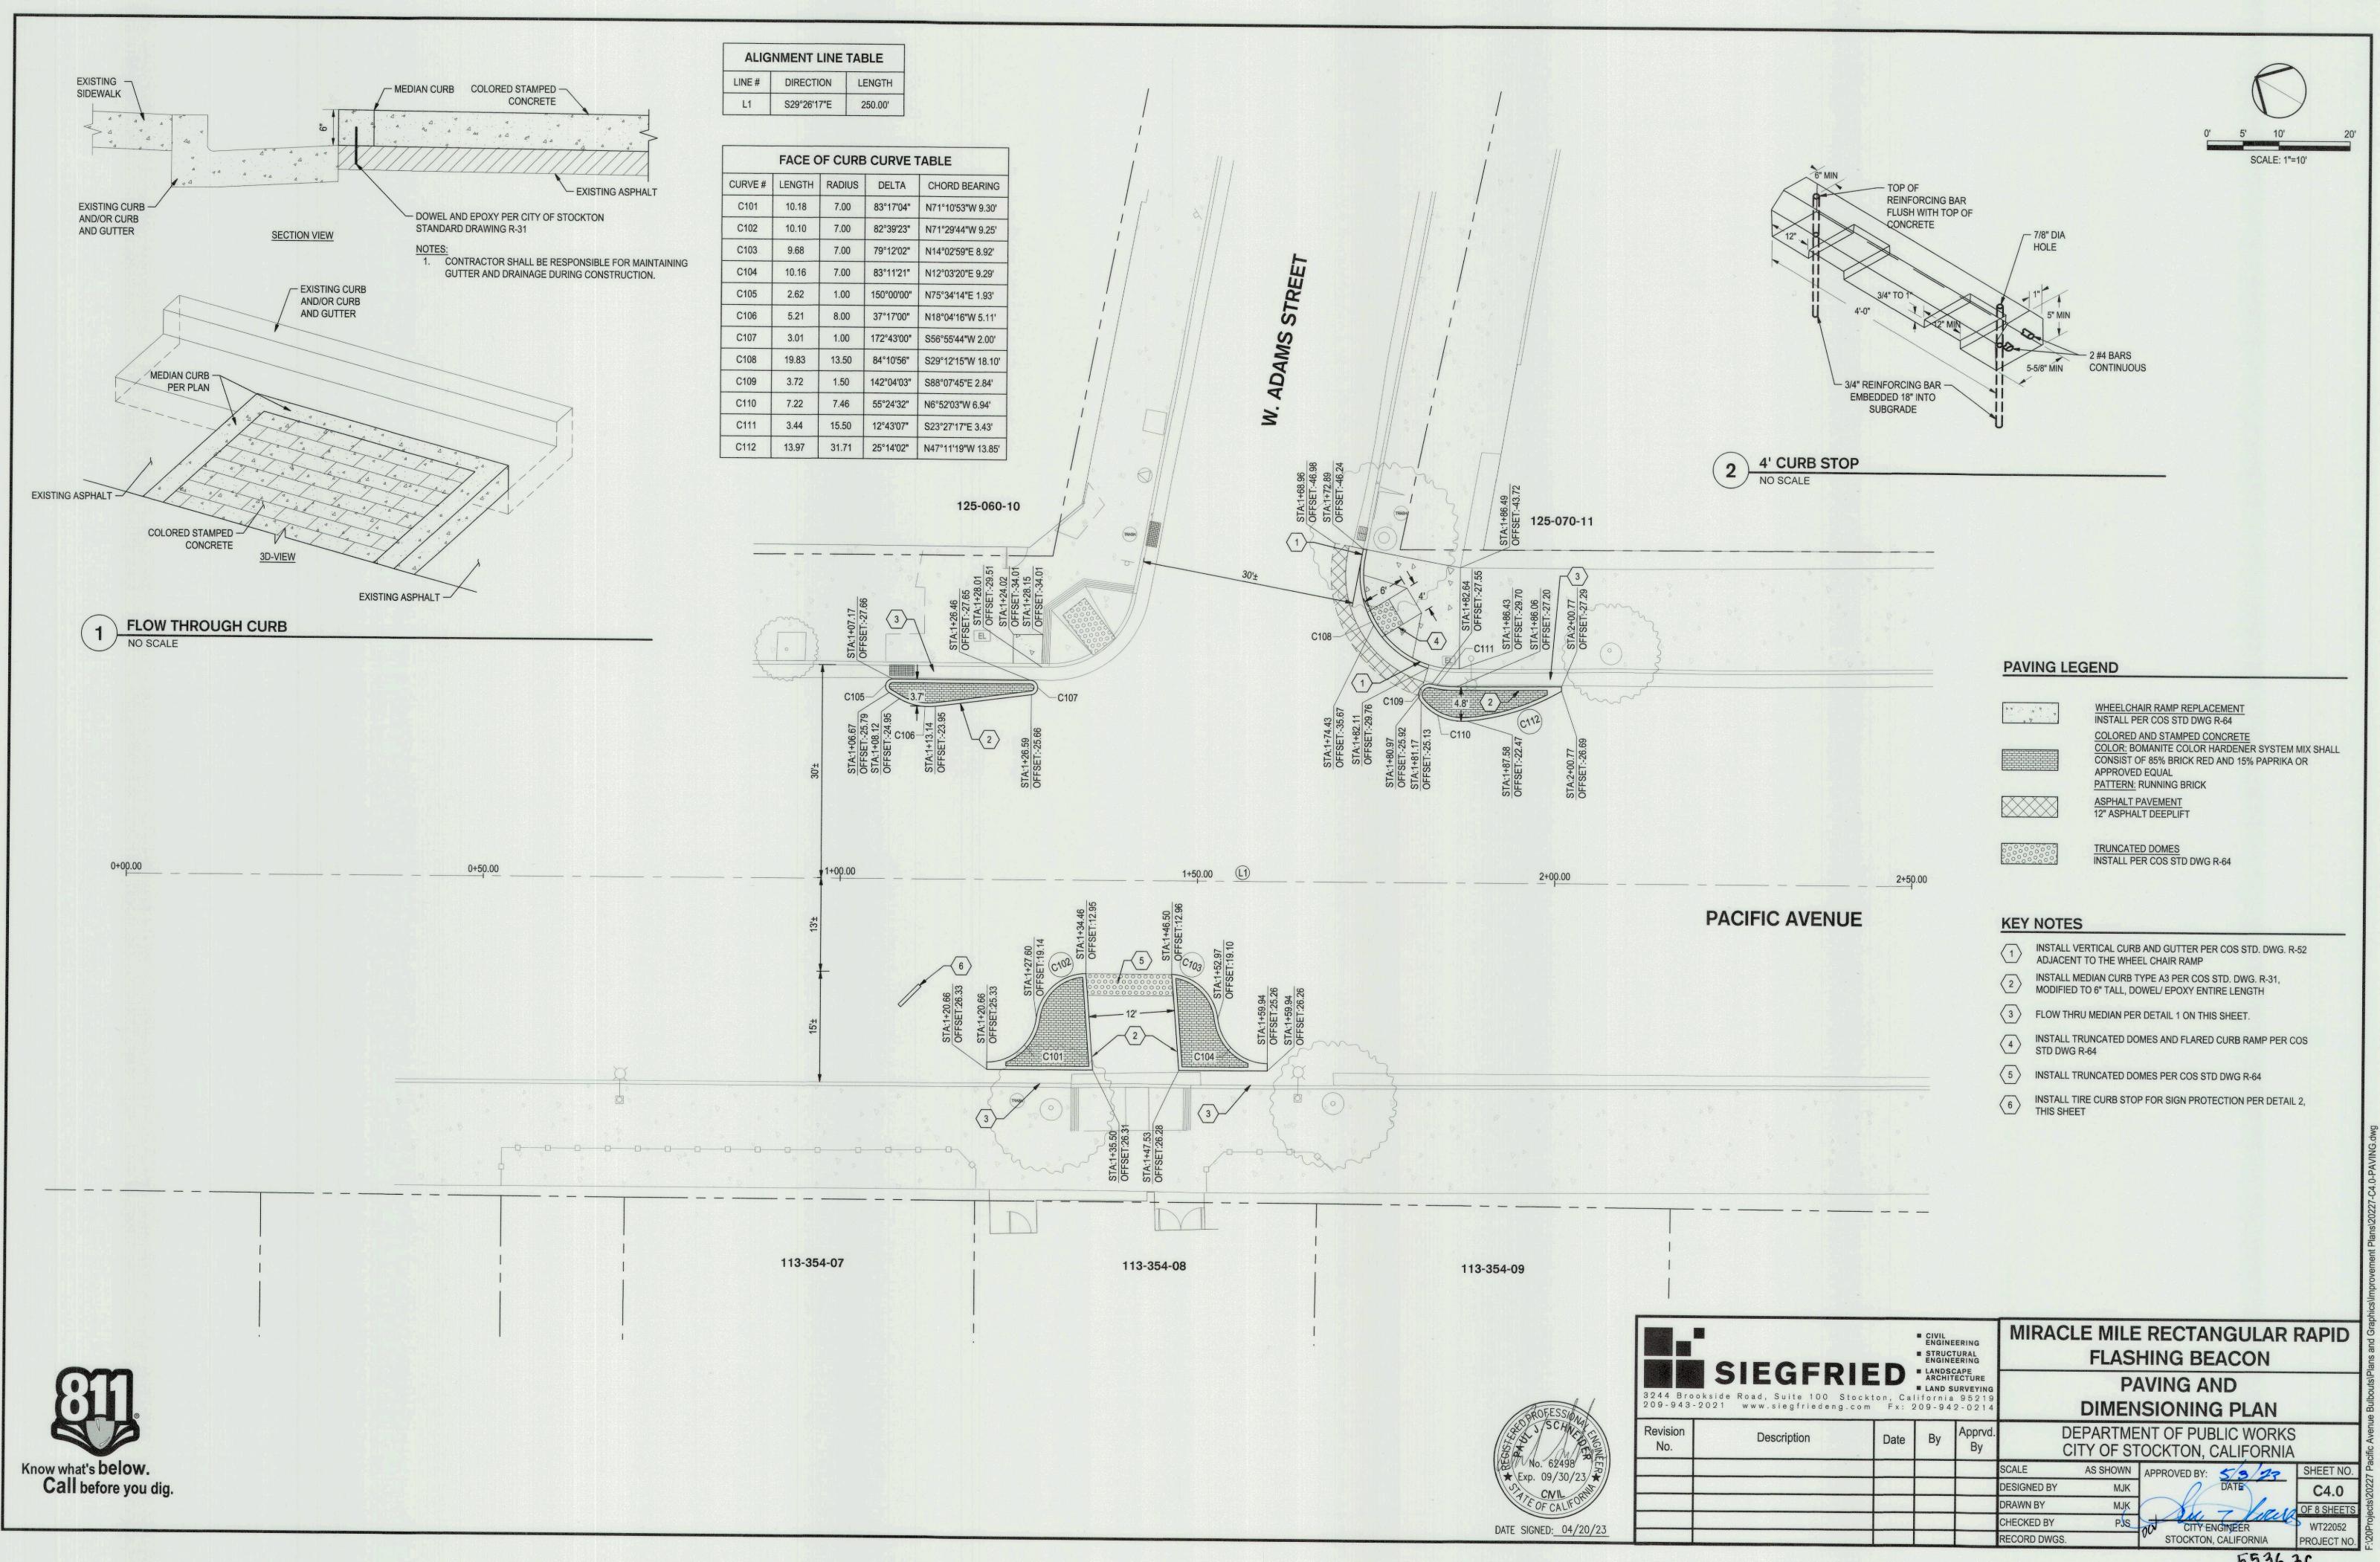



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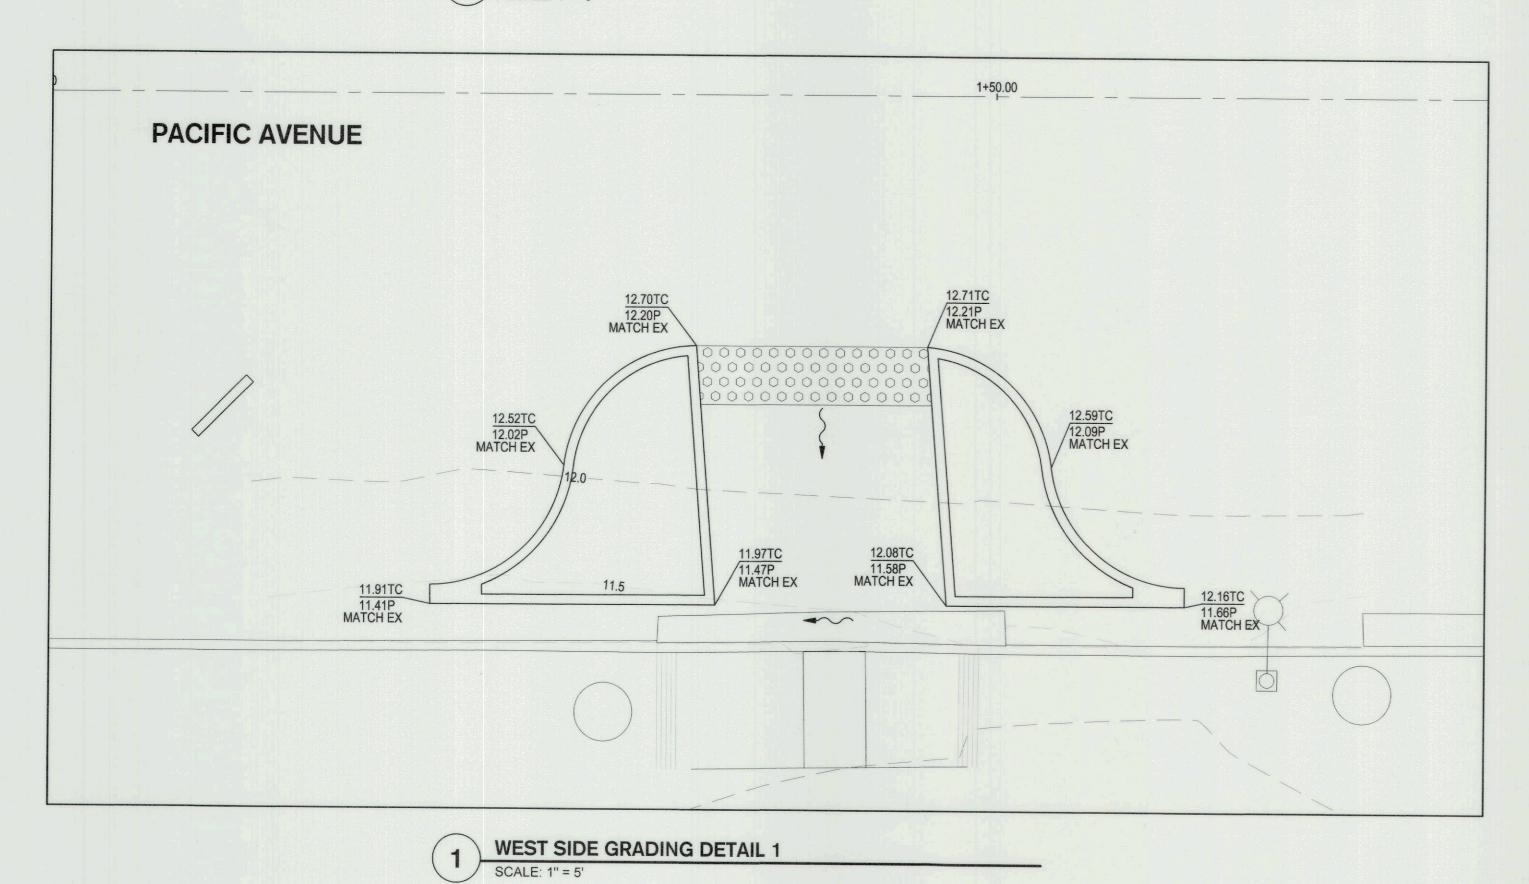
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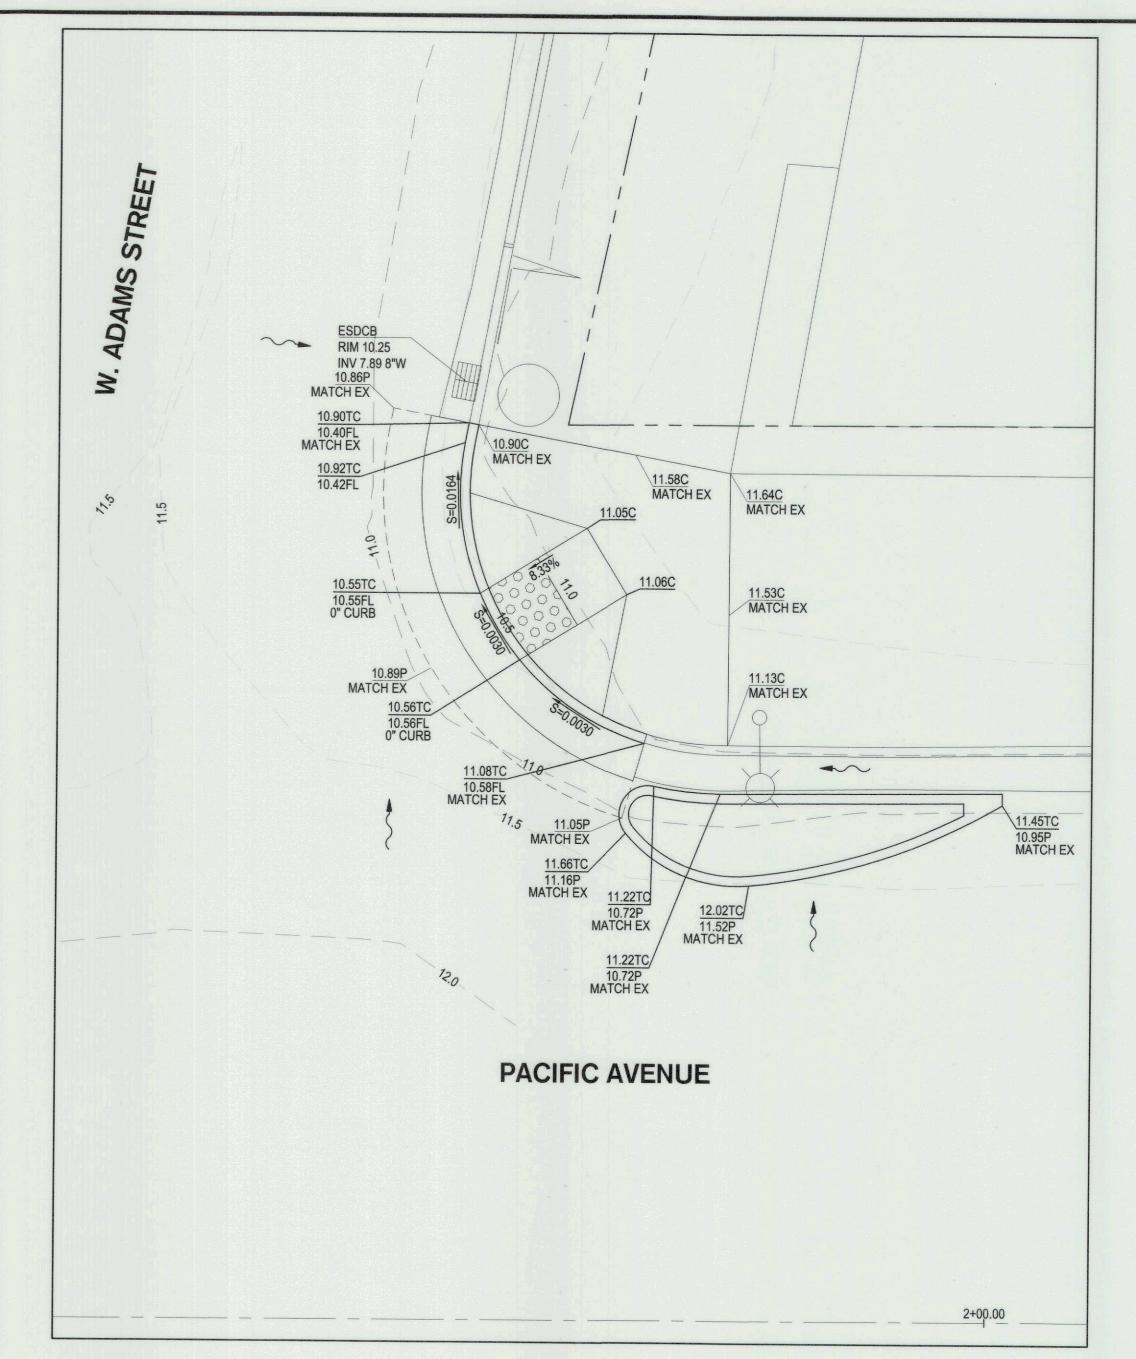
2 NORTHEAST CORNER GRADING DETAIL 2

SCALE: 1" = 5"

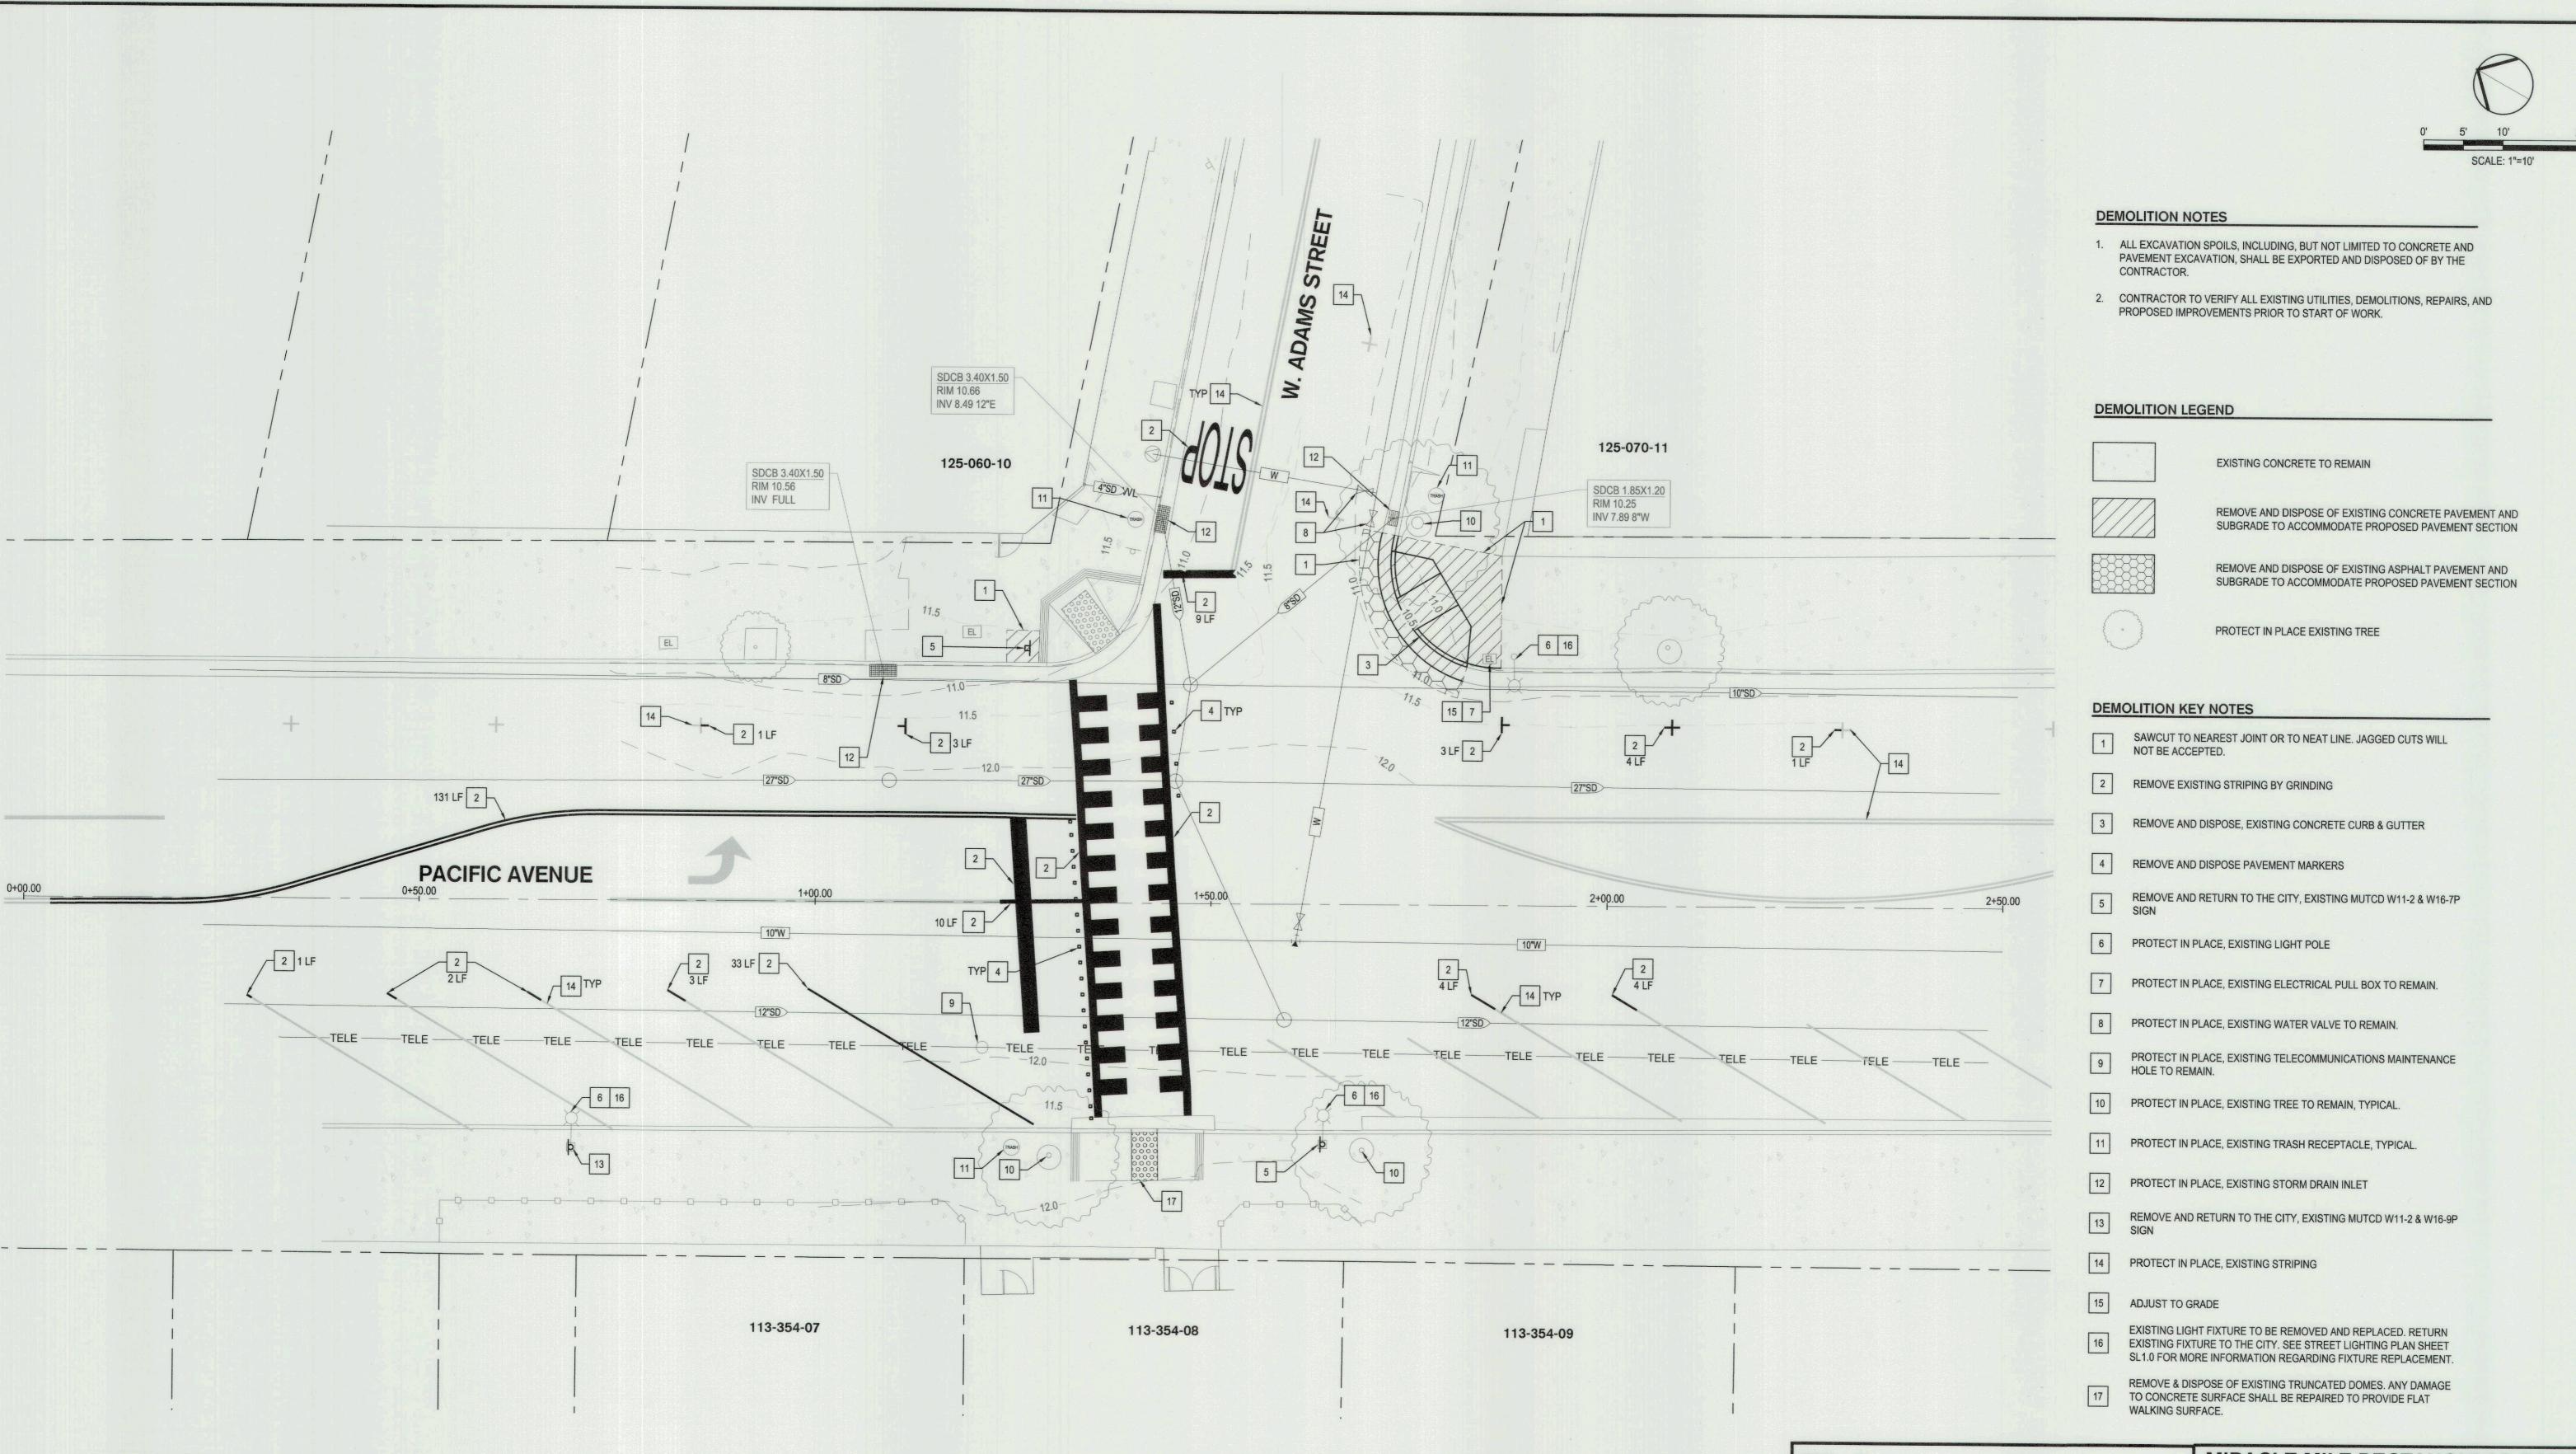



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3 SCALE: 1" = 5'




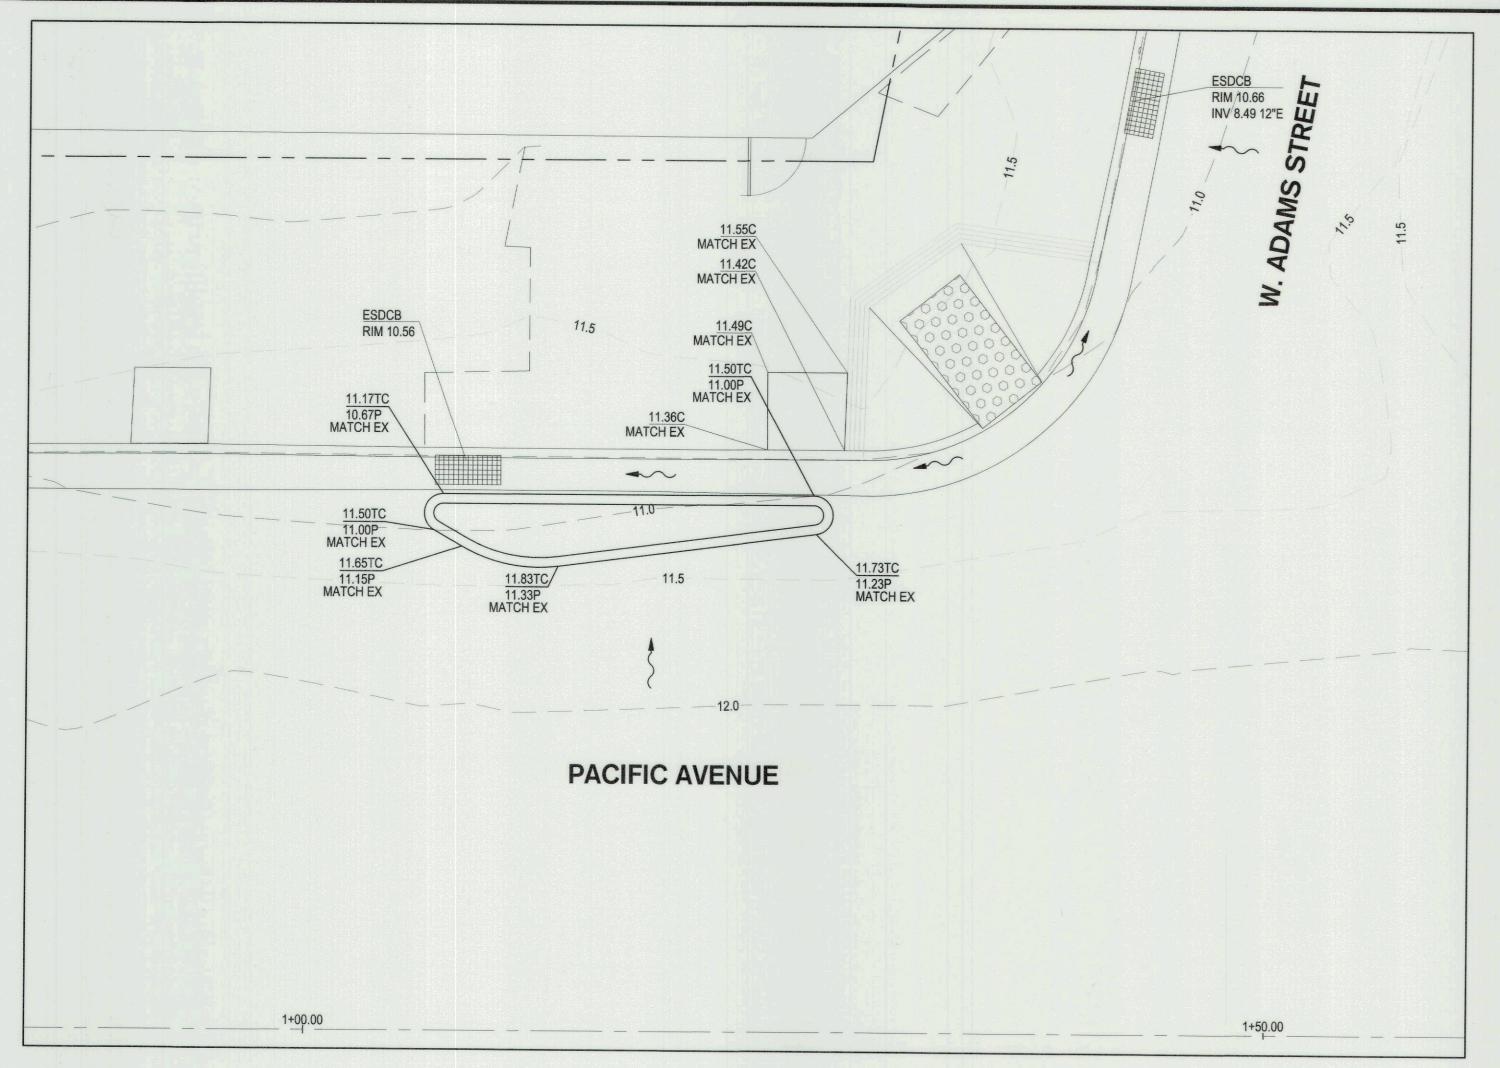

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SIEGFRIED LANDSCAPE ARCHITECTURE LAND SURVEYING 3244 Brookside Road, Suite 100 Stockton, California 95219 209-943-2021 www.siegfriedeng.com Fx: 209-942-0214					GRADING PLAN				
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DRAWN BY CHECKED BY

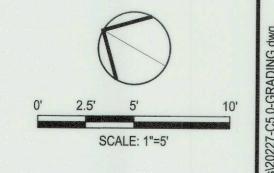CHY ENGINEER STOCKTON, CALIFORNIA THE FOLLOWING DETAILS AND NOTES SHALL BE USED THROUGHOUT THE PROJECT IN ORDER TO COMPLY WITH STATE AND LOCAL CONSTRUCTION BEST MANAGEMENT PRACTICES (BMP'S) AND THE STATE GENERAL PERMIT. CONTRACTOR SHALL BE RESPONSIBLE FOR PREPARING A STORMWATER POLLUTION PREVENTION PLAN (SWPPP) AND OBTAINING A STATE WAS DISCHARGE IDENTIFICATION NUMBER (WDID) AS WELL AS MAINTAINING THE SWPPP.

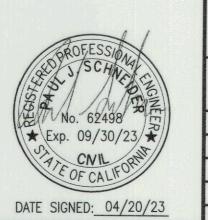

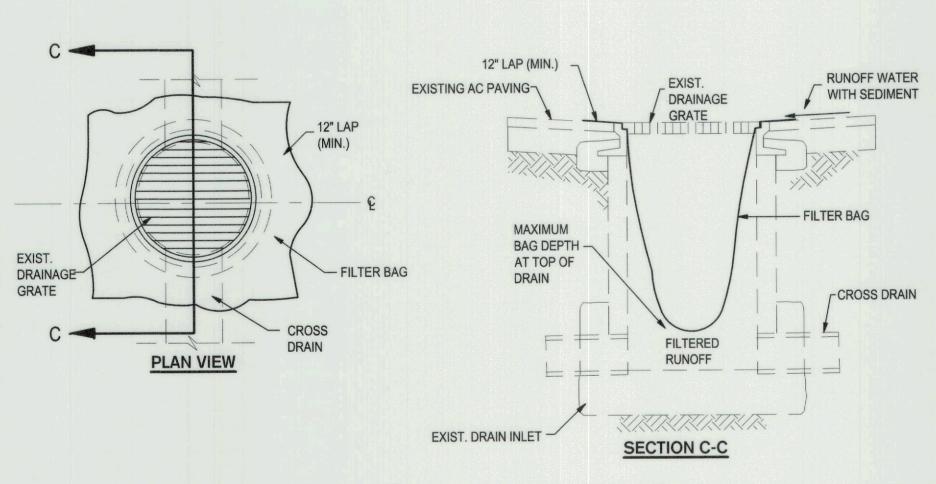TEMPORARY GRAVEL BAG FILTER AT DROP INLET


DROP INLET SEDIMENT PROTECTION NO SCALE

TYPICAL APPLICATION:

STORM INLET FILTER BAG DEVICES SHALL BE PROVIDED, INSTALLED, AND MAINTAINED FOR ALL INLETS THAT COULD POTENTIALLY RECEIVE SEDIMENT LADEN RUNOFF OR CONSTRUCTION WASH WATER.

EROSION CONTROL GENERAL NOTES

- INSPECT AND REPAIR FILTERS AFTER EACH STORM EVENT. REMOVE SEDIMENT WHEN 1/2 OF THE
 FILTER DEPTH HAS BEEN FILLED. REMOVED SEDIMENT SHALL BE DEPOSITED IN AN AREA TRIBUTARY
 TO A SEDIMENT BASIN OR OTHER FILTERING MEASURE. SEDIMENT AND GRAVEL SHALL BE
 IMMEDIATELY REMOVED FROM PAVEMENT OF ROAD.
- 2. ALTERNATE INLET PROTECTION SHALL BE USED ON ROADS OPEN TO THE PUBLIC IF ANY HAZARDOUS MATERIALS OR WASTES WHICH HAVE BEEN TREATED, STORED, DISPOSED, SPILLED, OR LEAKED IN SIGNIFICANT QUANTITIES ONTO THE CONSTRUCTION SITE, THE CONTRACTOR SHALL BE RESPONSIBLE TO REMOVE THEM FROM THE SITE AND DISPOSE OF PROPERLY.
- 3. THE CONTRACTOR SHALL KEEP MAINTENANCE, INSPECTION, AND REPAIR PROCEDURES TO ENSURE THAT ALL GRADED SURFACES, WALLS, BERMS, DRAINAGE STRUCTURES, VEGETATION, EROSION AND SEDIMENT CONTROL MEASURES, AND OTHER CONTROLS ARE MAINTAINED IN GOOD AND EFFECTIVE CONDITION AND ARE PROMPTLY REPAIRED OR RESTORED WHEN NECESSARY. ANY DEWATERING WATER SHALL NOT BE DISCHARGED DIRECTLY INTO THE STORM WATER SYSTEM, AND SHALL NOT BE DISCHARGED INTO THE SEWER SYSTEM.
- PAVEMENT CLEANING- FLUSHING OF STREETS/ PARKING LOTS TO REMOVE DIRT AND CONSTRUCTION DEBRIS IS PROHIBITED UNLESS PROPER SEDIMENT CONTROLS ARE USED. PREFERABLY, AREAS REQUIRING CLEANING SHOULD BE SWEPT.
- 5. CONCRETE TRUCKS SHALL BE WASHED AT AN OFFSITE LOCATION OR A PRE-MANUFACTURED RENTABLE UNIT SHALL BE UTILIZED ONSITE.

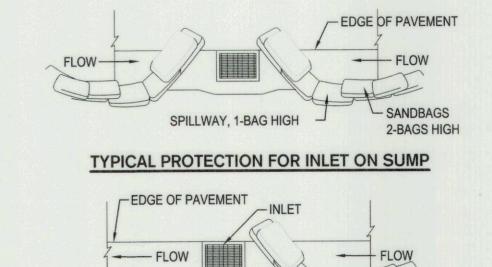

TYPICAL PROTECTION FOR INLET ON GRADE


SPILLWAY, 1-BAG HIGH


- NOTES:
 1. INTENDED FOR SHORT-TERM USE.
- USE TO INHIBIT NON-STORM WATER FLOW.
 ALLOW FOR PROPER MAINTENANCE AND CLEANUP.
- 4. BAGS MUST BE REMOVED AFTER ADJACENT OPERATION IS COMPLETED.
 5. NOT APPLICABLE IN AREAS WITH HIGH SILTS AND CLAYS WITHOUT FILTER FABRIC.

2 DI PROTECTION-TYPE 3 NO SCALE

TYPICAL APPLICATION:

THIS METHOD CAN BE USED AS AN ALTERNATE TO DETAIL 1

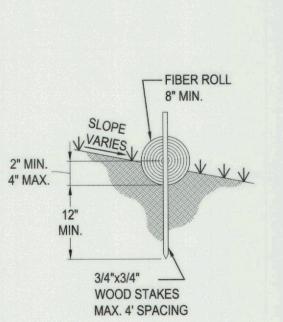

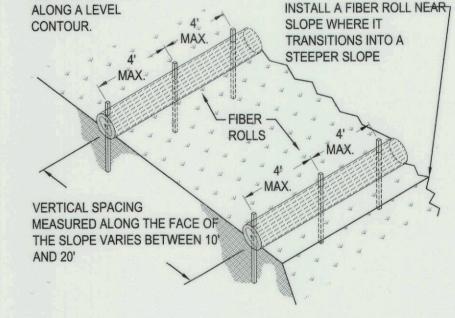

ENTRENCHMENT DETAIL

TYPICAL FIBER ROLL INSTALLATION

3 FIBER ROLLS

INSTALL FIBER ROLL

TYPICAL APPLICATION:

 FIBER ROLLS SHALL BE INSTALLED AND MAINTAINED IN LOCATIONS SUCH AS THE BACK OF WALK IN ORDER TO PREVENT SEDIMENT FROM WASHING ONTO CONCRETE OR ASPHALT.





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STOCKTON, CALIFORNIA

